

Alterations & Additions - 13 Shepard St, Umina W & J Nuttall

## **GENERAL NOTES**

1. BUILDER MUST CHECK ALL BOUNDARIES AND BUILDING DIMENSIONS PRIOR TO COMMENCING ANY BUILDING WORKS IN ORDER TO SATISFY HIMSELF THAT THE WORKS CAN BE CARRIED OUT IN ACCORDANCE WITH LOCAL COUNCIL AND RELATIVE AUTHORITY REQUIREMENTS

2. DO NOT SCALE DIMENSIONS OFF THE PLANS, FIGURED DIMENSIONS ARE TO BE USED. ALL DIMENSIONS ARE TO BE VARIFIED BY THE BUILDER ON SITE. ANY DISCREPENCIES SHALL BE REFERED TO THE DESGNERS BEFORE ANY CONSTRUCTION OR FABRICATION IS

3. THESE DRAWINGS SHALL BE READ IN CONJUNCTION WITH THE

SPECIFICATION, STRUCTURAL ENGINEERING DETAILS AND ANY OTHER DOCUMENT THAT MAY BE ISSUED.

4. ALL BUILDING WORKS MUST COMPLY WITH CURRENT NCC, ALL REVELANT AUSTRALIAN STANDARDS & LOCAL COUNCIL REQUIREMENTS.

5. BUILDINGS ARE TO BE PROTECTED AGAINST TERMITES IN ACCORDANCE WITH AUSTRALIAN STANDARDS (AS 3660.1) - REQUIREMENTS.

6. SMOKE ALARMS ARE TO BE PROVIDED IN ACCORDANCE WITH NCC REQUIREMENTS NSW VARIATION 3.7.5.3 & 3.7.5.5


7. ALL STORMWATER AND SEWER WORKS MUST COMPLY WITH LOCAL COUNCIL AND

8. NO RESPONSIBILITY WILL BE ACCEPTED BY TIMBER & STONE BUILDING DESIGN IF ANY PART OR WHOLE OF THE DRAWINGS HAS BEEN MODIFIED, DELETED OR ADDED TO IN ANY


9. BUILDER MUST CHECK FOR LOCATION OF SERVICES INLUDING BUT NOT LIMITED TO SEWER, WATER, POWER, GAS, PHONE, FIBRE AND STORMWATER PRIOR TO THE COMMENCEMENT OF WORK. ONCE THE SEWER IS LOCATED IT IS THE BUILDERS RESPONSIBILITY TO DETERMINE WEATHER THE BUILDING LIES WITHIN THE ZONE OF

10. ALL FLOOR PLAN DESIGNS INCLUDING ELEVATIONS ARE COPYRIGHTED AND ARE THE PROPERTY OF TIMBER & STONE BUILDING DESIGN AND MAY NOT BE REPRODUCED BY ANY MEANS WITHOUT WRITTEN PERMISSION



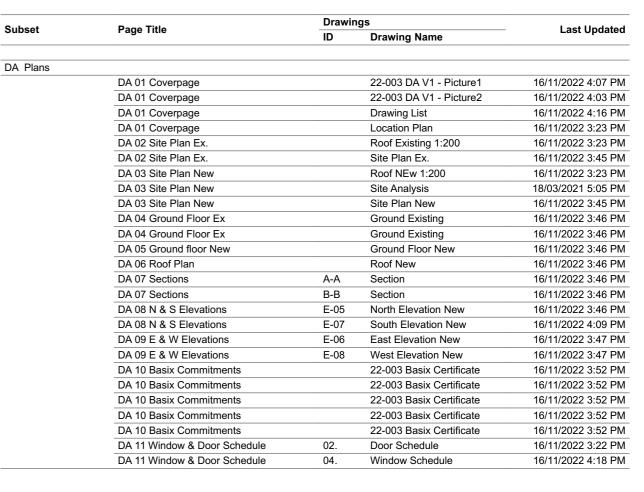



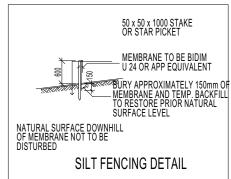

# **Location Plan**


# DUST CONTROL MEASURES:

IF THE SITE BECOMES DUSTY DURING HOTTER MONTHS (CLIENT) WILL SPRINKLE WATER ON THE DUST

### NOISE & VIBRATION MEASURES:

ALL EXCAVATION WILL BE CARRIED OUT BETWEEN THE TIME SETOUT IN THE COUNCIL CONDITIONS

MACHINERY SIZE WILL BE KEPT TO A MINIMUM REQUIRED FOR THE JOB

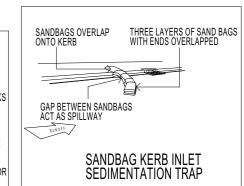

		<b>\</b>
TIMBER	&	STONE

BUILDING DESIGN 0405 175 086

Drawn | Checked CA | Plot Date: Project NO. Project Status

16/11/2022 22-003

Client Climate Zone Wind Region Site

Warrick & Jenny Nuttall #Climate Zone #Wind Region 13 Shepard Street Umina NSW **DRAWING TITLE:** 

Coverpage

PROJECT NAME:

22-003

DRAWING NO.

Site Lot Size
FSR
Ex. House
Ex.Sunroom
Ex. Carport

0.5:1 or 302.35m2 118.11m2 22.7m2 32m2

604.7m2


Ex Site coverage 140.81m2

New Addition 31.84m2

New Addition31.84m2New deck area33.02m2New Total FSR182.97m2

Landscape Area After 88.7m2



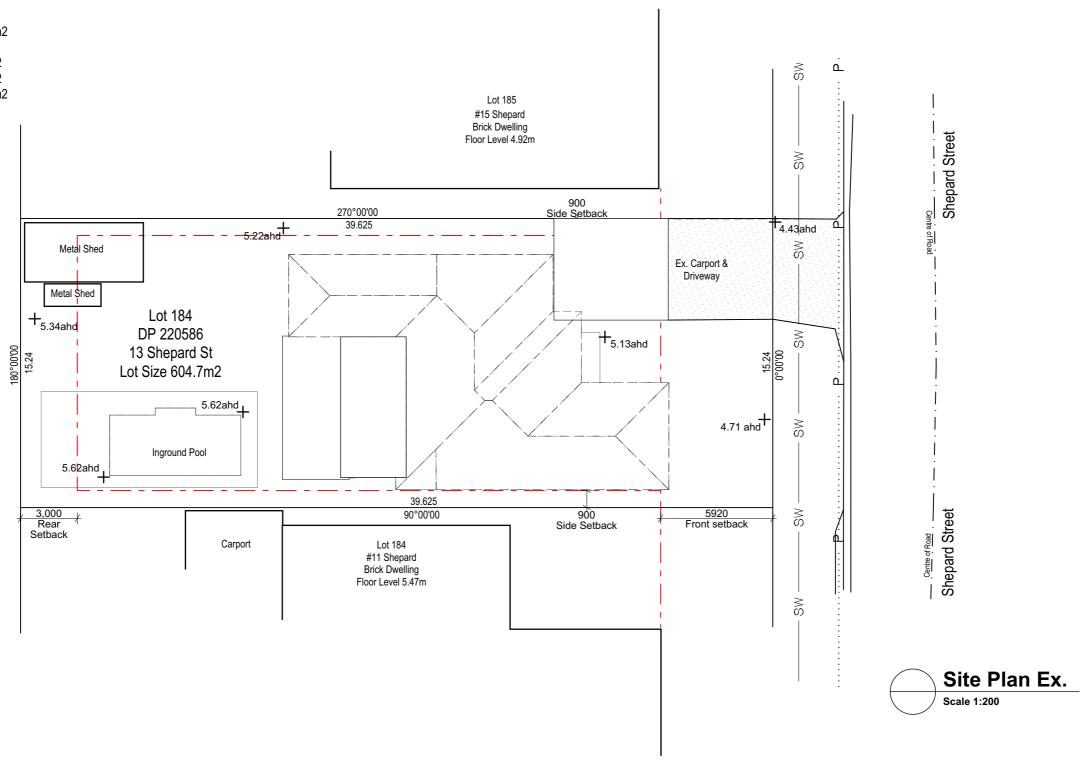

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TIMBER	&	STONE
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BUILDING DESIGN 0405 175 086 Drawn | Checked CA |
Plot Date: 16/11/2022
Project NO. 22-003
Project Status DA V1

Client Warrick & Jenny Nuttall
Climate Zone #Climate Zone
Wind Region #Wind Region
Site: 13 Shepard Street Umina NSW
2257

DRAWING TITLE :

Site Plan Ex.

PROJECT NAME:

22-003

DRAWING NO.

Site Lot SIze 604.7m2 FSR 0.5:1 or 302.35m2 Ex. House 118.11m2 Ex.Sunroom 22.7m2 Ex. Carport 32m2 140.81m2 Ex Site coverage


New Total FSR


New Addition 31.84m2 33.02m2 New deck area

182.97m2

88.7m2 Landscape Area After



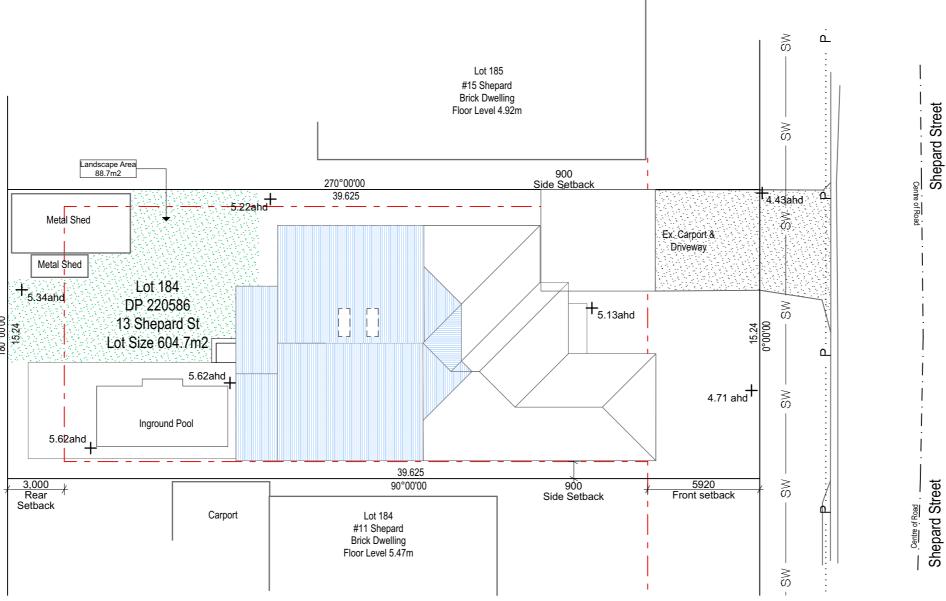

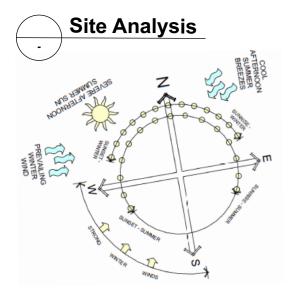

**Site Plan New** Scale 1:200

STORMWATER TO BE CONNECTED TO EXISTING SYSTEM

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TIMBER &	& STONE
BUILDING	DESIGN

0405 175 086


Drawn | Checked CA | 16/11/2022 22-003 Plot Date: Project NO. Project Status DA V1 Warrick & Jenny Nuttall Client

Site:

Climate Zone #Climate Zone Wind Region #Wind Region 13 Shepard Street Umina NSW 2257 DRAWING TITLE: Site Plan New

PROJECT NAME: 22-003 DRAWING NO.



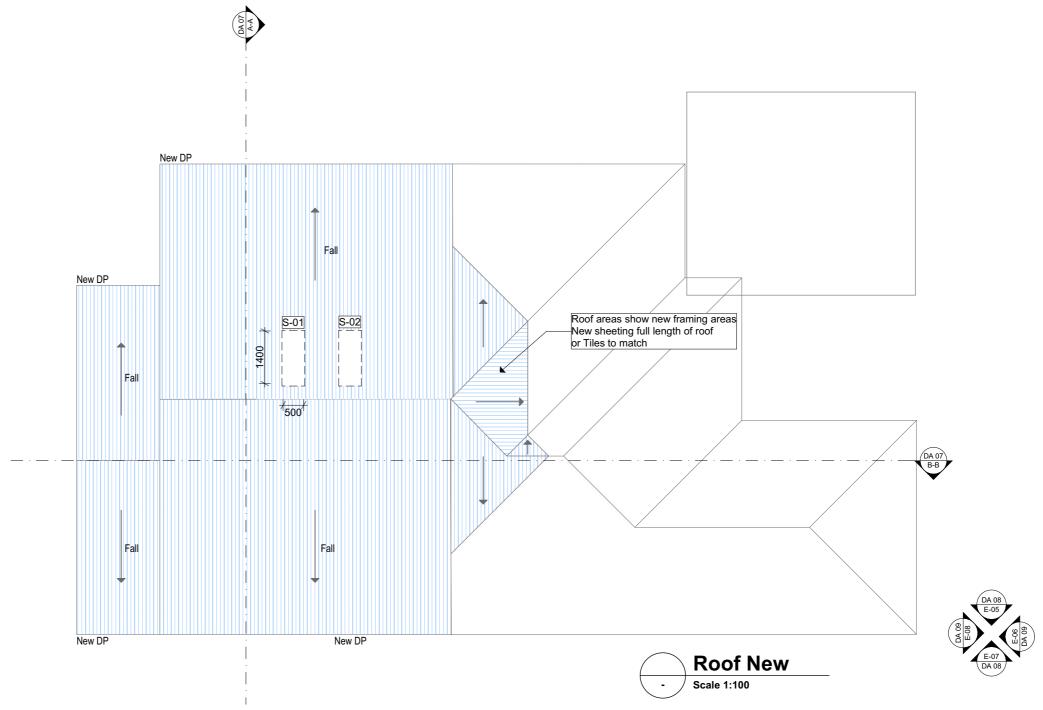

CONSTRUCTION IS TO BE IN ACCORDANCE WITH NCC AND RELEVANT AUSTRALIAN STANDARDS

TERMITE PROTECTION TO AS3660.2-2000

STORMWATER TO BE CONNECTED TO EXISTING SYSTEM

TIMBER & STONE

BUILDING DESIGN 0405 175 086 Drawn | Checked CA |
Plot Date: 16/11/2022
Project NO. 22-003
Project Status DA V1

Client Warrick & Jenny
Climate Zone #Climate Zone
Wind Region
Site: #Wind Region
13 Shepard Stre


16/11/2022 22-003 DA V1 Warrick & Jenny Nuttall #Climate Zone #Wind Region 13 Shepard Street Umina NSW 2257 DRAWING TITLE :

Roof Plan

PROJECT NAME :

22-003

DRAWING NO.

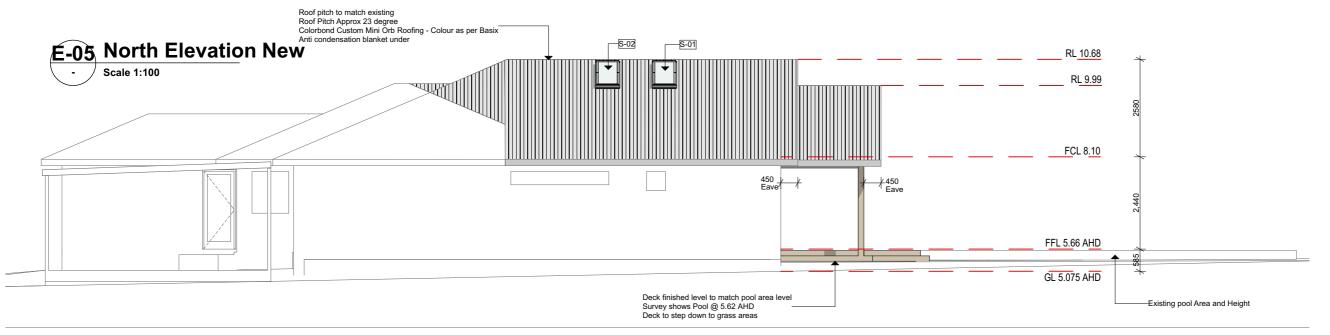





CONSTRUCTION IS TO BE IN ACCORDANCE WITH NCC AND RELEVANT AUSTRALIAN STANDARDS

TERMITE PROTECTION TO AS3660.2-2000

STORMWATER TO BE CONNECTED TO EXISTING SYSTEM

		•
TIMBER	&	STONE

BUILDING DESIGN 0405 175 086

Drawn | Checked CA | Plot Date: Project NO. Project Status

16/11/2022 22-003 DA V1

Client Climate Zone Wind Region Site:

Warrick & Jenny Nuttall #Climate Zone #Wind Region 13 Shepard Street Umina NSW 2257

DRAWING TITLE:


**N & S Elevations** 

PROJECT NAME:

22-003

DRAWING NO.



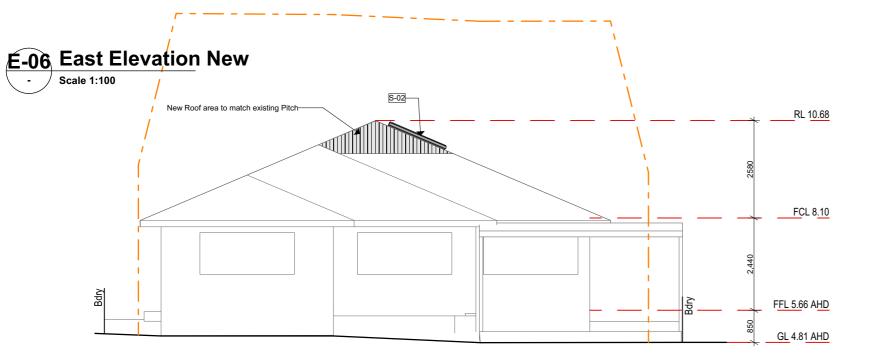

# Scale 1:100 RL 10.68 Roof Pitch Approx 23 degree Colorbond Custom Mini Orb Roofing - Colour as per Basix Anti condensation blanket under RL 9.99 FCL 8.10 FCL 8.10 FEL5.66 AHD GG IS.41 AHD

WB Denotes cladding finish

CONSTRUCTION IS TO BE IN ACCORDANCE WITH NCC AND RELEVANT AUSTRALIAN STANDARDS

TERMITE PROTECTION TO AS3660.2-2000

STORMWATER TO BE CONNECTED TO EXISTING SYSTEM

		•
TIMBER	&	STONE

BUILDING DESIGN 0405 175 086 Drawn | Checked CA |
Plot Date: 16/11/2022
Project NO. 22-003
Project Status DA V1

Client Warrick & Jenny Nuttall

Client Warrick & Jenny Nuttall
Climate Zone #Climate Zone
Wind Region #Wind Region
Site: 13 Shepard Street Umina NSW
2257

DRAWING TITLE :

E & W Elevations

PROJECT NAME :

22-003

DRAWING NO.



Building Sustainability Index www.basix.nsw.gov.au

# Alterations and Additions

Certificate number: A477880

This certificate confirms that the proposed development will meet the NSW government's requirements for sustainability, if it is built in accordance with the commitments set out below. Terms used in this certificate, or in the commitments, have the meaning given by the document entitled "BASIX Alterations and Additions Definitions" dated 06/10/2017 published by the Department. This document is available at www.basix.nsw.gov.au

Secretary

Date of issue: Wednesday, 16, November 2022
To be valid, this certificate must be lodged within 3 months of the date of issue.



Project address	
Project name	22-003 Nuttal
Street address	13 Shepard Street Umina Beach 2257
Local Government Area	Central Coast Council
Plan type and number	Deposited Plan 220586
Lot number	184
Section number	
Project type	
Dwelling type	Separate dwelling house
Type of alteration and addition	My renovation work is valued at \$50,000 or more, and does not include a pool (and/or spa).

Certificate Prepared by (please complete before submitting to Council or PCA)
Name / Company Name: Northlight Building Pty Ltd
ABN (if applicable): 38138184764

BASIX Certificate number: A477880 page 3 / 6

of project

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Construction			Show on DA Plans	Show on CC/CDC Plans & specs	Certifier Check
Insulation requirements					
	d construction (floor(s), walls, and ceilings/roofs) tion is not required where the area of new constr where insulation already exists.		<b>~</b>	<b>✓</b>	<b>~</b>
Construction	Additional insulation required (R-value)	Other specifications			
suspended floor with enclosed subfloor: framed (R0.7).	R0.60 (down) (or R1.30 including construction)				
external wall: framed (weatherboard, fibro, metal clad)	R1.30 (or R1.70 including construction)				
external wall: framed (weatherboard, fibro, metal clad)	R1.30 (or R1.70 including construction)				
external wall: framed (weatherboard, fibro, metal clad)	R1.30 (or R1.70 including construction)				
external wall: framed (weatherboard, fibro, metal clad)	R1.30 (or R1.70 including construction)				
raked ceiling, pitched/skillion roof: framed	ceiling: R2.24 (up), roof: foil backed blanket (55 mm)	medium (solar absorptance 0.475 - 0.70)			



BASIX Certificate number: A477880

Fixtures and systems	Show on DA Plans	Show on CC/CDC Plans & specs	Certifier Check
Lighting			
The applicant must ensure a minimum of 40% of new or altered light fixtures are fitted with fluorescent, compact fluorescent, or light-emitting-diode (LED) lamps.		<b>~</b>	~

BASIX Certificate number: A477880 page 4 / 6

	quirements						Show on DA Plans	Show on CC/CDC Plans & specs	Certifier Check
Windows a	nd glazed do	ors							
					shading devices, in accordance with or each window and glazed door.	the specifications listed in the table below.	<b>✓</b>	<b>✓</b>	<b>✓</b>
The following	g requirements	must also	be satisf	ied in relatio	n to each window and glazed door:			~	<b>~</b>
have a U-val	ue and a Solar	Heat Gair	n Coeffici	ent (SHGC)		ed glass may either match the description, or, le below. Total system U-values and SHGCs s.		<b>✓</b>	<b>✓</b>
					of each eave, pergola, verandah, bal than 2400 mm above the sill.	lcony or awning must be no more than 500 mm	<b>✓</b>	<b>✓</b>	<b>~</b>
								_	
Pergolas with	n polycarbonate	e roof or s	imilar trar	nslucent mat	erial must have a shading coefficier	nt of less than 0.35.		~	~
Pergolas with	n fixed battens	must have	battens	parallel to th	ŭ	ich they are situated, unless the pergola also		<i>*</i>	<b>~</b>
Pergolas with shades a per	n fixed battens in pendicular wind glazed	must have dow. The doors g	battens spacing b	parallel to the between batt	ne window or glazed door above whitens must not be more than 50 mm.	ich they are situated, unless the pergola also		<i>*</i>	<b>V</b>
Pergolas with shades a per	n fixed battens i	must have dow. The doors g Area of glass inc. frame	battens spacing b	parallel to the	ne window or glazed door above whitens must not be more than 50 mm.	ich they are situated, unless the pergola also		<b>*</b>	<b>*</b>
Pergolas with shades a per Windows Window / do	n fixed battens in pendicular wind glazed	must have dow. The doors g Area of glass inc.	e battens spacing b lazing r Oversha	parallel to the petween batter equirement adowing Distance	ne window or glazed door above whitens must not be more than 50 mm.	ich they are situated, unless the pergola also		<b>*</b>	<b>*</b>
Pergolas witt shades a per Windows Window / do no.	an fixed battens of pendicular wind glazed of Orientation	dow. The dow. The dows g Area of glass inc. frame (m2)	e battens spacing b lazing r Oversha Height (m)	parallel to the petween batter equirement adowing  Distance (m)	en e window or glazed door above whitens must not be more than 50 mm.  ents  Shading device  eave/verandah/pergola/balcony	Frame and glass type standard aluminium, single clear, (or		<b>*</b>	<b>*</b>
Pergolas with shades a per Windows Window / do no.	and glazed or Orientation	doors g Area of glass inc. frame (m2)	e battens spacing b lazing r Oversha Height (m)	parallel to the petween batter requirement adowing Distance (m)	ne window or glazed door above whitens must not be more than 50 mm.  Shading device  eave/verandah/pergola/balcony >=450 mm  eave/verandah/pergola/balcony	Frame and glass type  standard aluminium, single clear, (or U-value: 7.63, SHGC: 0.75) standard aluminium, single clear, (or		<b>*</b>	<b>*</b>

BASIX Certificate number: A477880 page 5 / 6

Glazing require	ements			Show on DA Plans	Show on CC/CDC Plans & specs	Certifier Check
The applicant mus	st install the skyligh	ts in accordance with the specifi	cations listed in the table below.	✓	✓	<b>~</b>
The following requ	uirements must also	be satisfied in relation to each	skylight:		✓	~
Each skylight may the table below.	either match the d	escription, or, have a U-value ar	d a Solar Heat Gain Coefficient (SHGC) no greater than that listed in		<b>✓</b>	✓
Skylights glaz	ing requiremer	nts				
Skylight number	Area of glazing inc. frame (m2)	Shading device	Frame and glass type			
	0.75	no shading	timber, double clear/air fill, (or U-value: 4.3, SHGC: 0.5	5)		
S1	0.75		(0. 0. 10.00.	,		



BUILDING DESIGN 0405 175 086 Drawn | Checked CA |
Plot Date: 16/11/2022
Project NO. 22-003
Project Status DA V1

Client Climate Zone Wind Region Site: Warrick & Jenny Nuttall #Climate Zone #Wind Region 13 Shepard Street Umina NSW 2257 DRAWING TITLE:

Basix Commitments

PROJECT NAME:

22-003

DRAWING NO.



ID	Leaf Width	Opening Width	Opening Height	QTY	Head Height	Plan Preview	Elevation	Notes
D-01		4,500	2,100	1	2,100	<del></del>	4500	Glazing as per BASIX

### Window Schedule

Width	Height	QTY	Head Height	Elevation	Outside Frame Finish	Notes
750	1,481	1	2,100	750	Metal - Aluminium	Glazing as per Basix
1,500	1,200	1	2,100	1,500	Metal - Aluminium	Glazing as per Basix
2,400	1,200	1	2,100	2,400	Metal - Aluminium	Glazing as per Basix



0405 175 086

Drawn | Checked CA |
Plot Date: 16/11/2022
Project NO. 22-003
Project Status DA V1

Site:

Client Warrick & Jenny Nuttall Climate Zone #Climate Zone Wind Region #Wind Region

#Ulmate Zone
#Wind Region
13 Shepard Street Umina NSW
2257

DRAWING TITLE:

Window & Door Schedule

PROJECT NAME:

22-003

DRAWING NO.