




SITE PLAN (1:200)
UNIT 2, UNIT 3 & VISITOR ENTRY PATHS

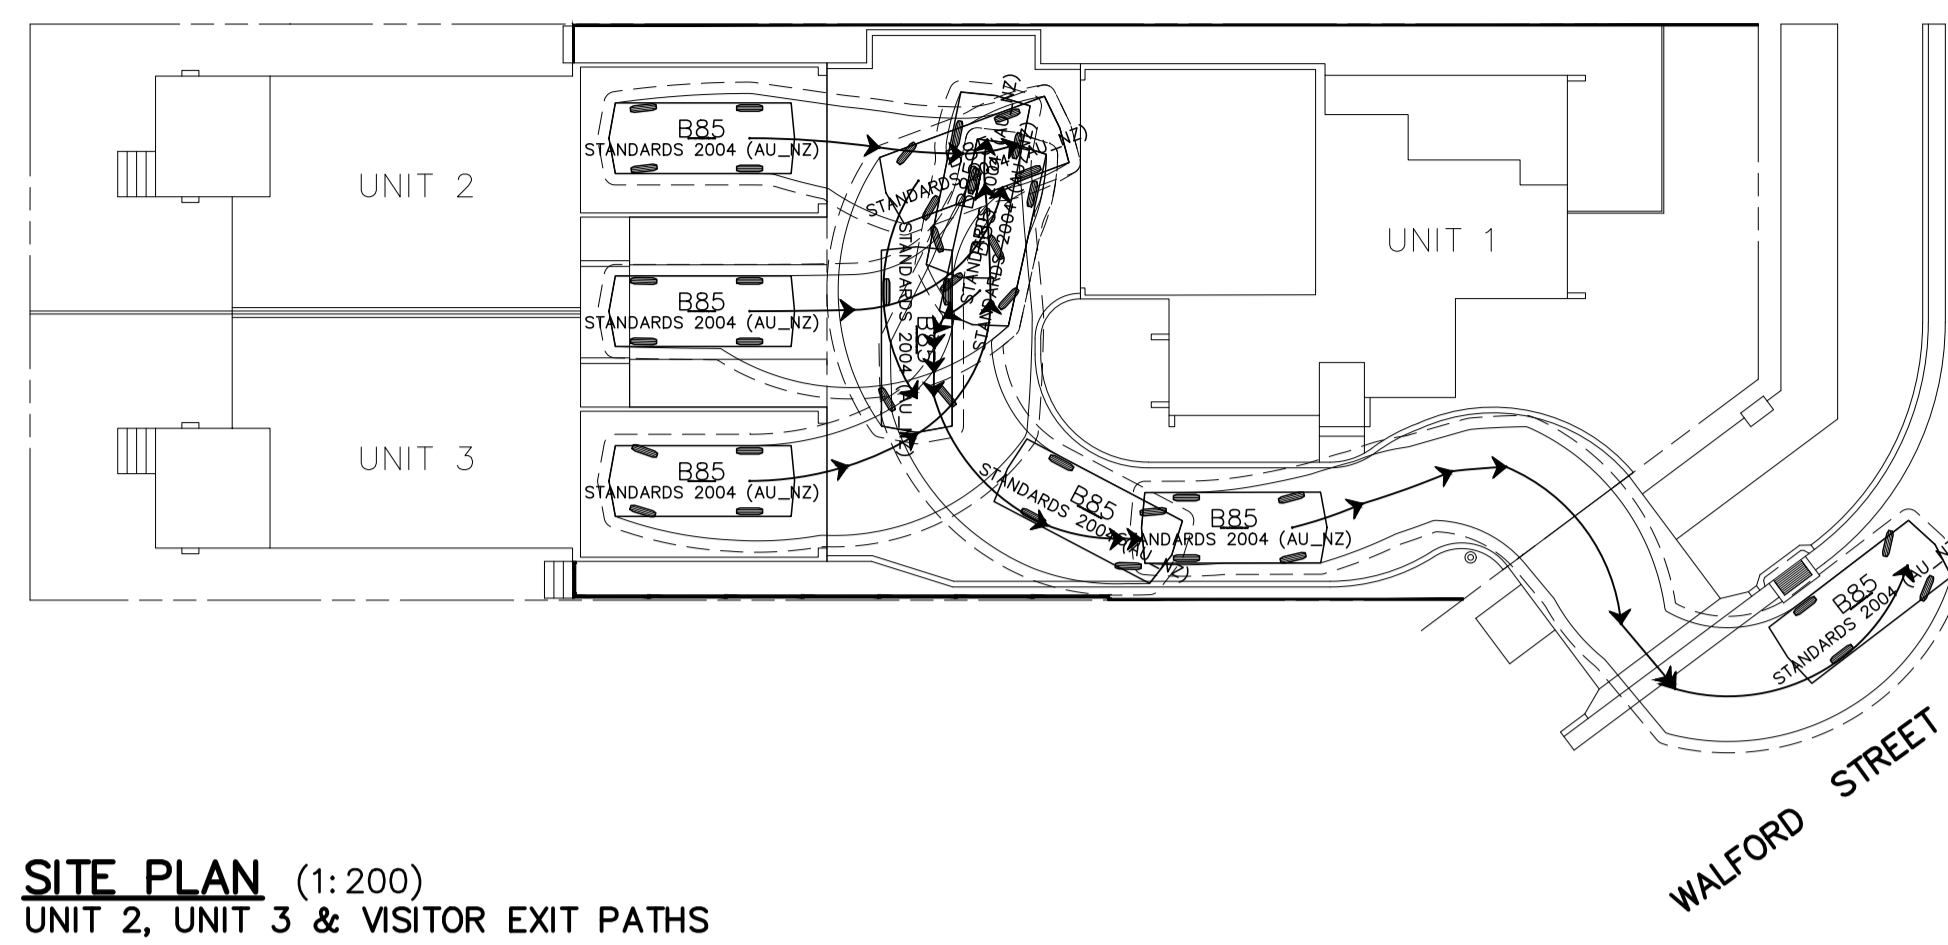


SITE PLAN (1:200)
UNIT 2, UNIT 3 & VISITOR EXIT PATHS

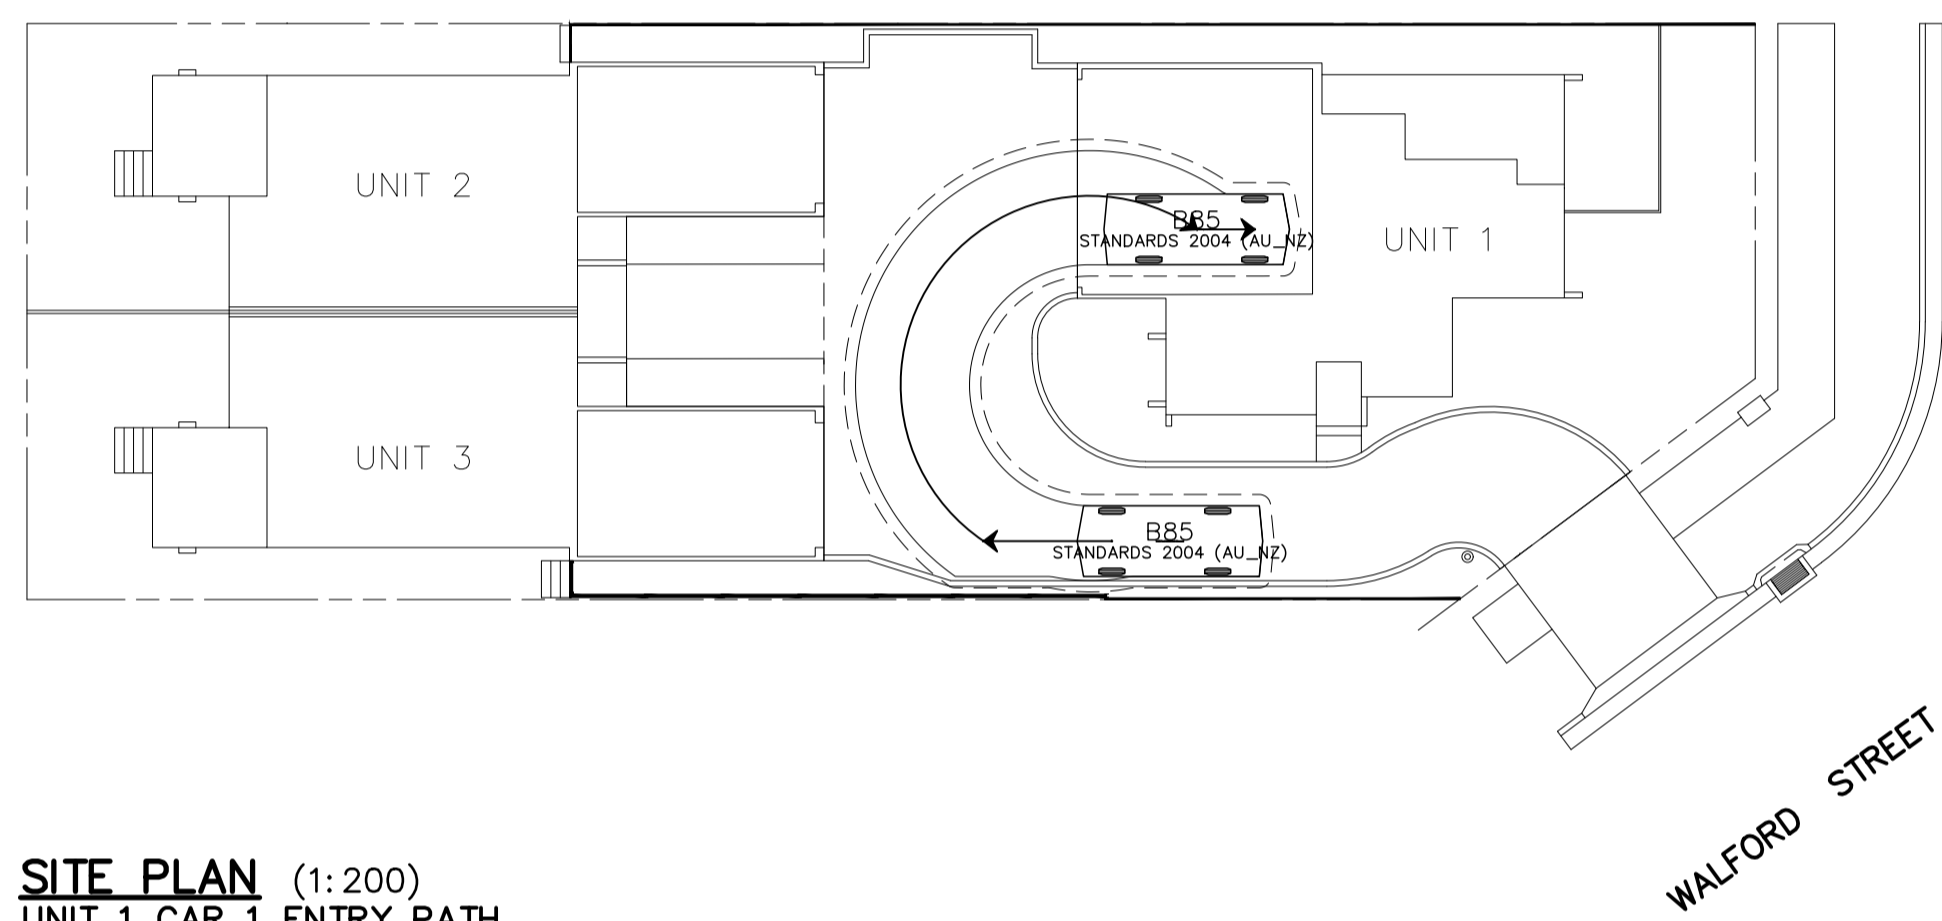


SITE PLAN (1:200)
UNIT 1 CAR 1 ENTRY PATH

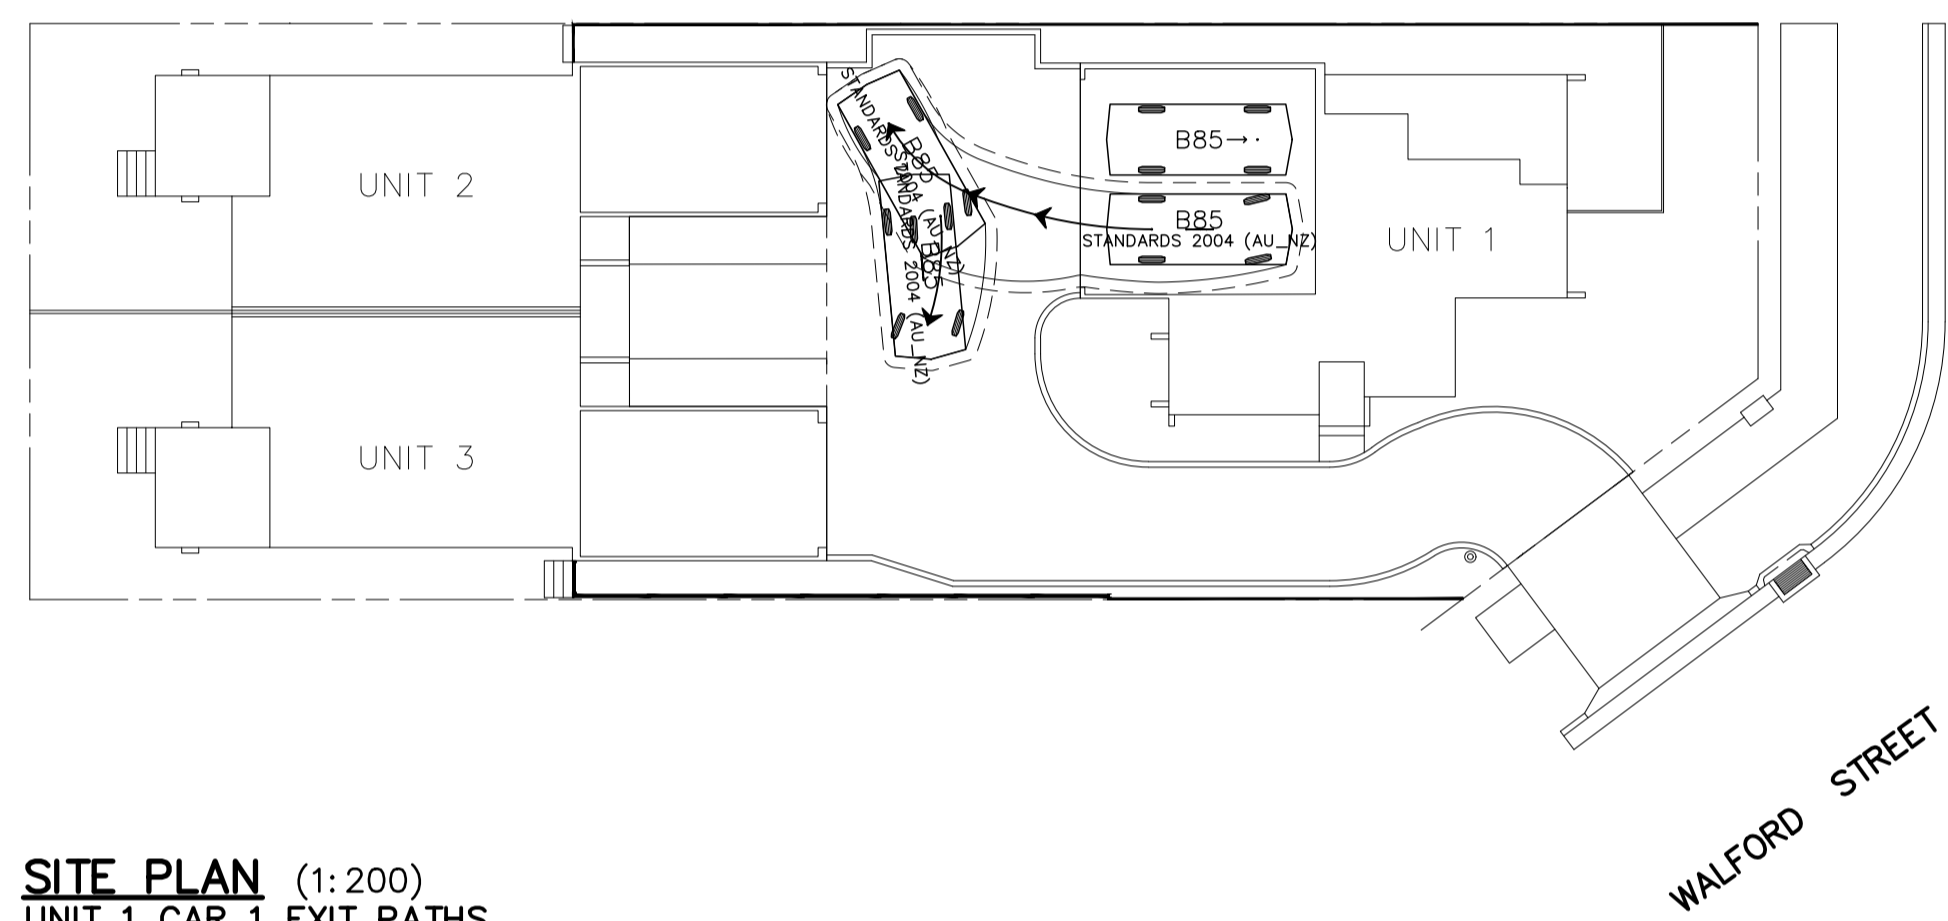

SITE PLAN (1:200)
UNIT 1 CAR 1 EXIT PATHS

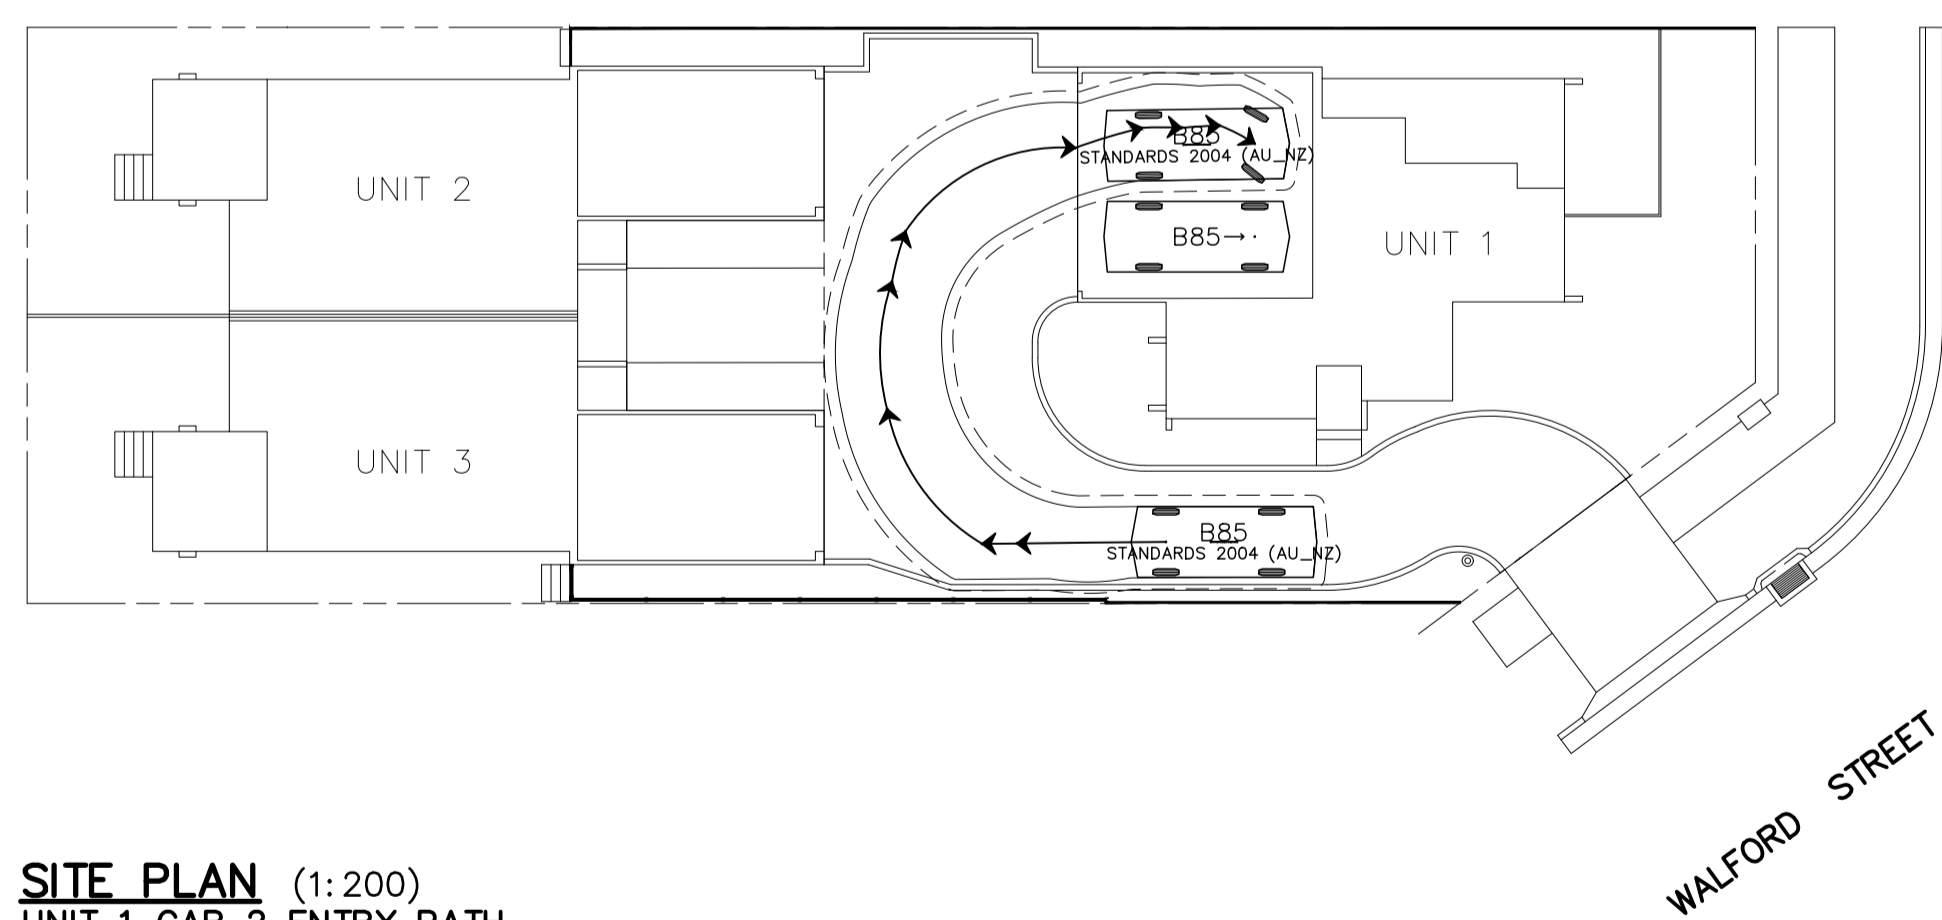

SITE PLAN (1:200)
UNIT 1 CAR 2 ENTRY PATH

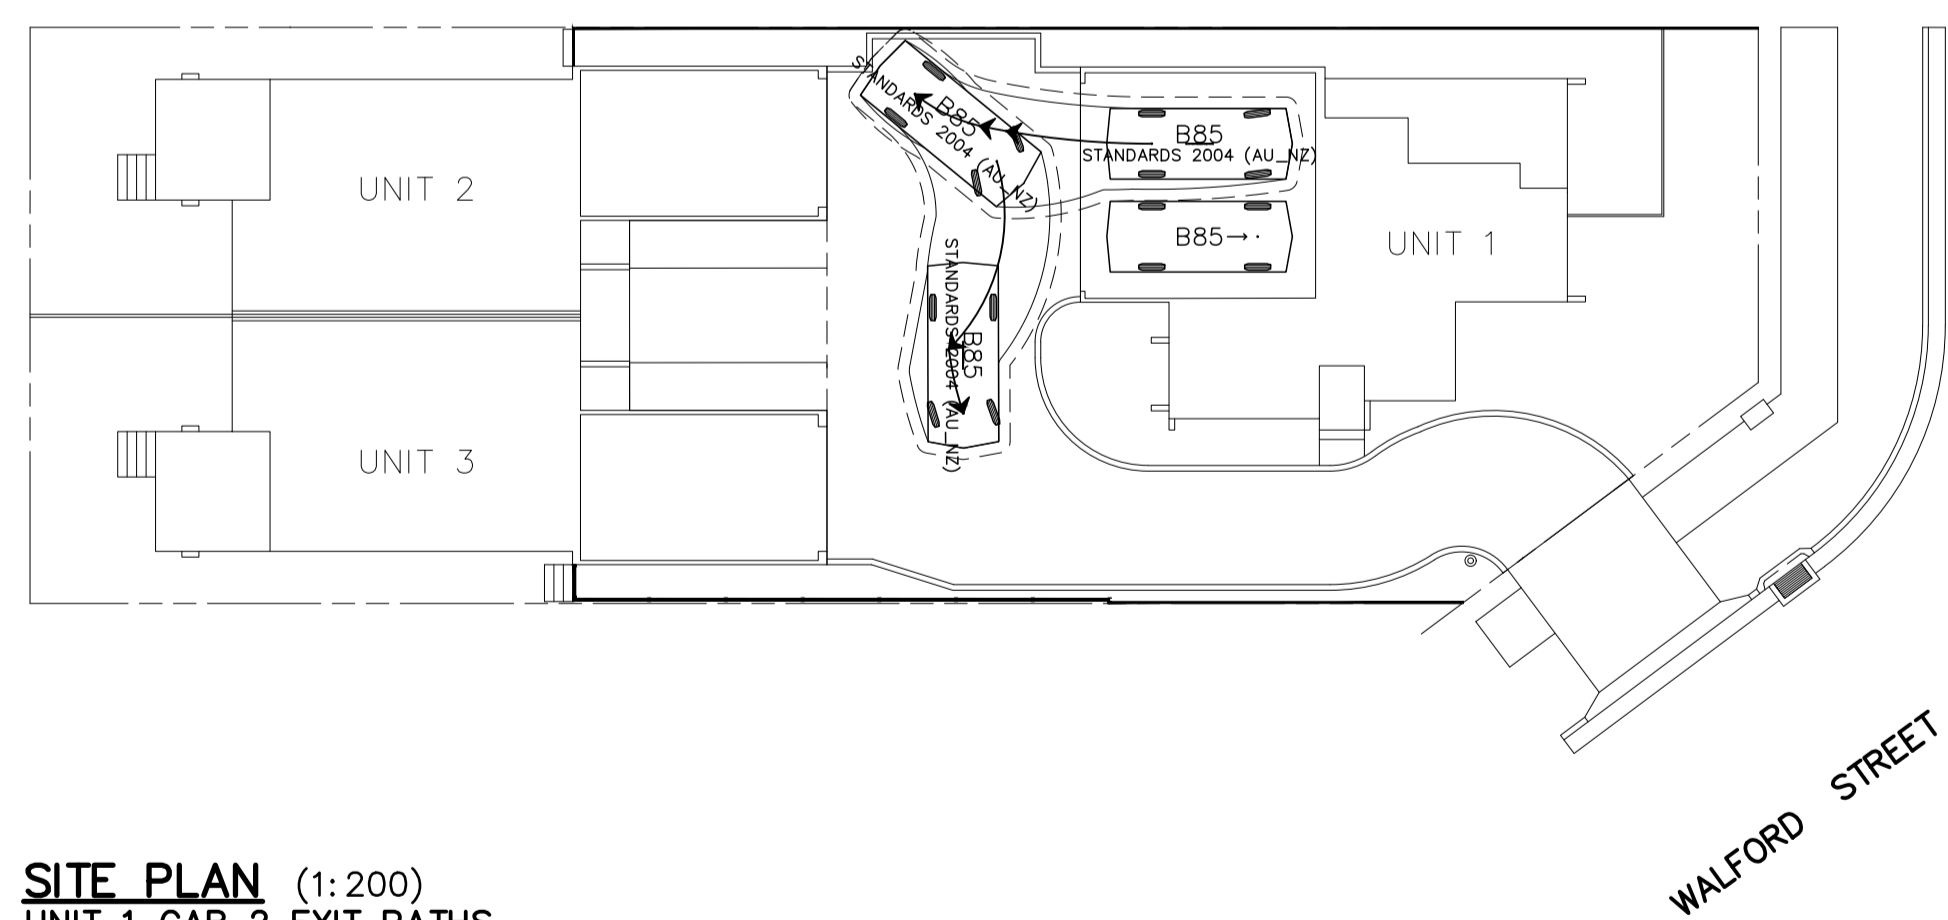

SITE PLAN (1:200)
UNIT 1 CAR 2 EXIT PATHS

Turning circles and Vehicle Swept Paths shown on Plan are for B85 base dimension swept path in accordance with AS 2890.1.

AS 2890 REQUIREMENTS — UP TO 3 UNITS			
ITEM	REQUIREMENT	PROPOSAL	COMPLIANCE
DRIVEWAY WIDTH (CLAUSE 2.6.1)	3.0m MINIMUM	3.0m MINIMUM	YES
DRIVEWAY GRADIENT (CLAUSE 2.6.2)	25% MAXIMUM	10% MAXIMUM	YES
APRON WIDTH (FIGURE 5.4)	2.4m DOOR = 7.0m 2.7m DOOR = 6.3m 3.0m DOOR = 5.6m	3.3m DOOR = 6.7m 5.5m DOOR = 6.7m	YES
SINGLE GARAGE (CLAUSE 5.4a)	3.0m MINIMUM WIDE 2.4m WIDE DOOR	3.86m WIDE GARAGE 3.3m & 3.4m WIDE DOOR	YES
DOUBLE GARAGE (CLAUSE 5.4b)	5.4m MINIMUM WIDE 4.8m WIDE DOOR	5.96m WIDE GARAGE 5.5m WIDE DOOR	YES
GARAGE DOOR HEIGHT (CLAUSE 5.3.1)	2200mm MINIMUM	2200mm	YES



ORIGINAL SIZE = A1

ISSUE:	DATE:	DETAILS OF AMENDMENT:

HALCROW & ASSOCIATES
CONSULTING STRUCTURAL ENGINEERS
A.C.N. 003 805 374

108 Avoca Drive,
Kincumber, N.S.W. 2251.
P.O. Box 6349 Kincumber, 2251
Phone: (02) 4369-0977
Email: design@halcrow.com.au

DESIGN: P.A.J.	DRAWN: P.A.J.
DATE: 22.11.23	CHECKED: A.H.
SCALE: AS SHOWN	APPROVED: <i>Angela Halcrow</i>

CLIENT: Lina Guo	DRAWING NUMBER: 23.10.005
PROJECT: Proposed Multi Unit Development	No. IN SET: DA3 of 3
SITE: Lot 28 (No.135) Paton Street, WOY WOY	AMENDMENT:
TITLE: VEHICLE SWEEP PATH PLANS	

CAD FILE: 23100050A3