
AREA CALCULATION		
SITE AREA:	259 m²	
EXISTING BUILDING FOOTPRINT:	100.1 m <sup>2</sup>	
OTHER HARDSTAND AREA:	18.2 m²	
PROPOSED POOL & COPING:	12.2 m <sup>2</sup>	
TOTAL COVERED AREA:	130.5 m²	
SOFT LANDSCAPE ON ENTIRE LOT:	128.5 m <sup>2</sup>	
TOTAL LANDSCAPE		
MINIMUM LANDSCAPE REQUIRED:	25.9 m <sup>2</sup>	10%
TOTAL LANDSCAPED AREAS > 1.5m WIDE:	100.5 m²	38.8%
LANDSCAPE FORWARD OF BUILDING LINE		
AREA FORWARD OF BUILDING LINE	81.2 m²	
REQUIRED LANDSCAPE > 1.5m WIDE	20.3 m <sup>2</sup>	25%
PROPOSED LANDSCAPE > 1.5m WIDE	55.7	68.6%
LANDSCAPE BEHIND BUILING LINE		
REQUIRED LANDSCAPE > 1.5m WIDE	12.95 m <sup>2</sup>	50%
PROPOSED LANDSCAPE > 1.5m WIDE	44.8 m <sup>2</sup>	

NOTES: 1. THIS DRAWING IS TO BE READ IN CONJUNCTION WITH THE POOL MANUFACTURER'S DRAWINGS AND SPECIFICATIONS 2. POOL SETOUT TO WATERS EDGE 3. ALL SITE WORKS TO BE COMPLETED TO AUSTRALIAN STANDARDS, NATIONAL CONSTRUCTION CODE AND LOCAL GOVERNMENT AUTHORITIES REGULATIONS 4. POOL CONSTRUCTION, INCLUDING POOL BARRIER, STRICTLY TO COMPLY WITH ALL PARTS OF AS1926 AND THE SWIMMING POOL ACT & REGULATIONS 5. FINAL CERTIFICATION IS TO BE ACHIEVED PRIOR TO FILLING OF POOL 6. POOL PUMP TO BE HOUSED IN SOUND PROOF ENCLOSURE 7. ALL POOL WATER RUNOFF & FILTER BACK WASH TO BE HANDLED IN ACCORDANCE WITH AS1926 AND COUNCIL'S SPECIFICATION		DIS 600 200 NC DA
GROUND CLEARANCE: THE HEIGHT OF ANY OPENING BETWEEN THE BOTTOM OF THE BARRIER AND THE FINISHED GROUND LEVEL SHALL NOT EXCEED 100mm. THE SURFACE BENEATH THE BARRIER SHALL BE PERMANENT AND NOT EASILY REMOVED OR ERODED BY A YOUNG CHILD, ANIMALS OR WEATHER.		DA
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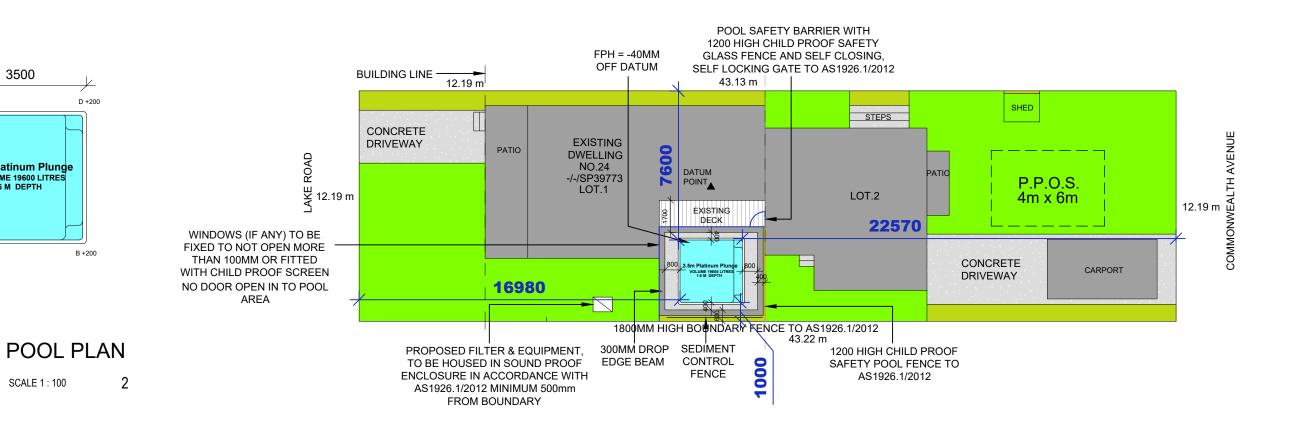
٦٢ 3000 MAX. GEOTEXTILE FILTER FABRIC (SUPPORTED) POSTS DRIVEN 600 INTO GROUND (JIMBER OR STEEL) ISTURBED AREA DIRECTION OF FLOW UNDISTURBED AREA -Sediment fence details SUITALE FOR AREA OF 0.8ha MAX. SLOPE GRADIENT 1:2 MAX. SLOPE LENGTH 60m MAX.

LEGEND	
	SOFT LANDSCAPE 1.5m WIDE & GREATER
	SOFT LANDSCAPE LESS THAN 1.5m WIDE
	HARDSTAND ( CONCRETE, PAVERS, GRAVEL ETC.)
	EXISTING BUILDING FOOTPRINT

IOTES: ATUM IS EXISTING DECK AND GROUND TO ATUM IS PLUS 350MM ATUM = FLOOR LEVEL OF HOUSE

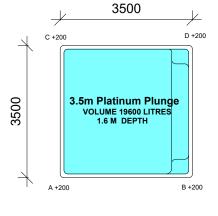

SCALE 1 : 100




	COPYRIGHT STATEMENT		DATE	DESCRIPTION	REV	CLIENT'S NAME:	SHEET NAME:			JOB NO:
≈voquepools	FOR THE PROJECT WORK INTENDED WITHOUT		07.07.2022 APPROVAL		R1	RAEWYN BURDEN SITE PLA		TE PLAN		200641
			21.07.2022 APPROVAL 11.08.2022 APPROVAL		R2		DESIGN NAME: RANGE:		SCALE @ A3: SHEET NO:	
			TT.00.2022 AFFICOVAL		113	SITE ADDRESS:	DESIGN NAME:	RANGE.	AS	SHEET NO.
	REPRODUCED BY ANY PROCESS, NOR MAY ANY	MILLIMETERS. DO NOT				24 Lake Road,	3.5M		indicated	1
	OTHER EXCLUSIVE RIGHT BE EXERCISED, WITHOUT	SCALE FROM PLANS.				Blackwall, NSW 2256,		PROJECT STAGE:		DATE:
local • independent • full inhouse	PERMISSION. LEGAL ENFORCEMENT WILL BE TAKEN ON COPYRIGHT INFRINGEMENT.					, ,	PLUNGE			
						-/-/SP39773	TEONOL	APPROVAL	3	11.08.2022
VERSION 1.04 C POWERED BY CANIBUILD					1		1	1	<u> </u>	
VERSION 1.04 🔘 POWERED BY CANIBUILD										




## SITE PLAN

SCALE 1 : 200

1

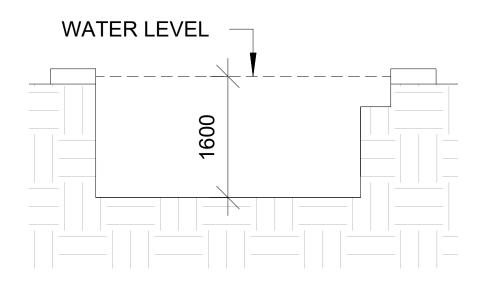


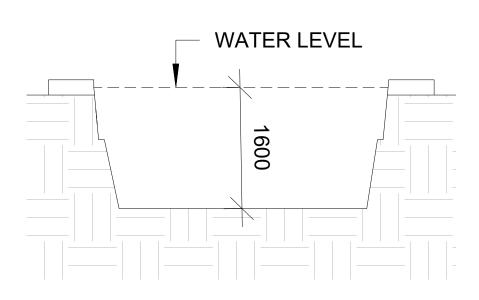

SOUTH ELEVATION

1

SCALE 1 : 50

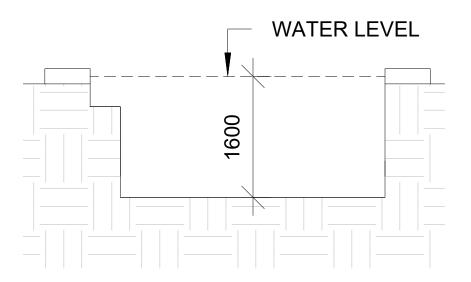


NORTH ELEVATION

3

SCALE 1 : 50

WEST ELEVATION


2 SCALE 1 : 50

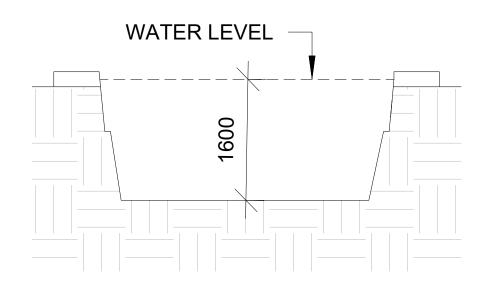


EAST ELEVATION

4

SCALE 1 : 50

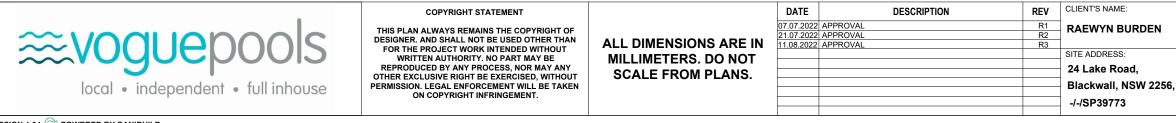

SHEET NAME:				JOB NO:		
N	SECTION	ECTION				
	DESIGN NAME:	RANGE:	SCALE @ A3:	SHEET NO:		
	3.5M		1:50	2		
256,	PLATINUM	PROJECT STAGE:	REV NO:	DATE:		
	PLUNGE	APPROVAL	3	11.08.2022		

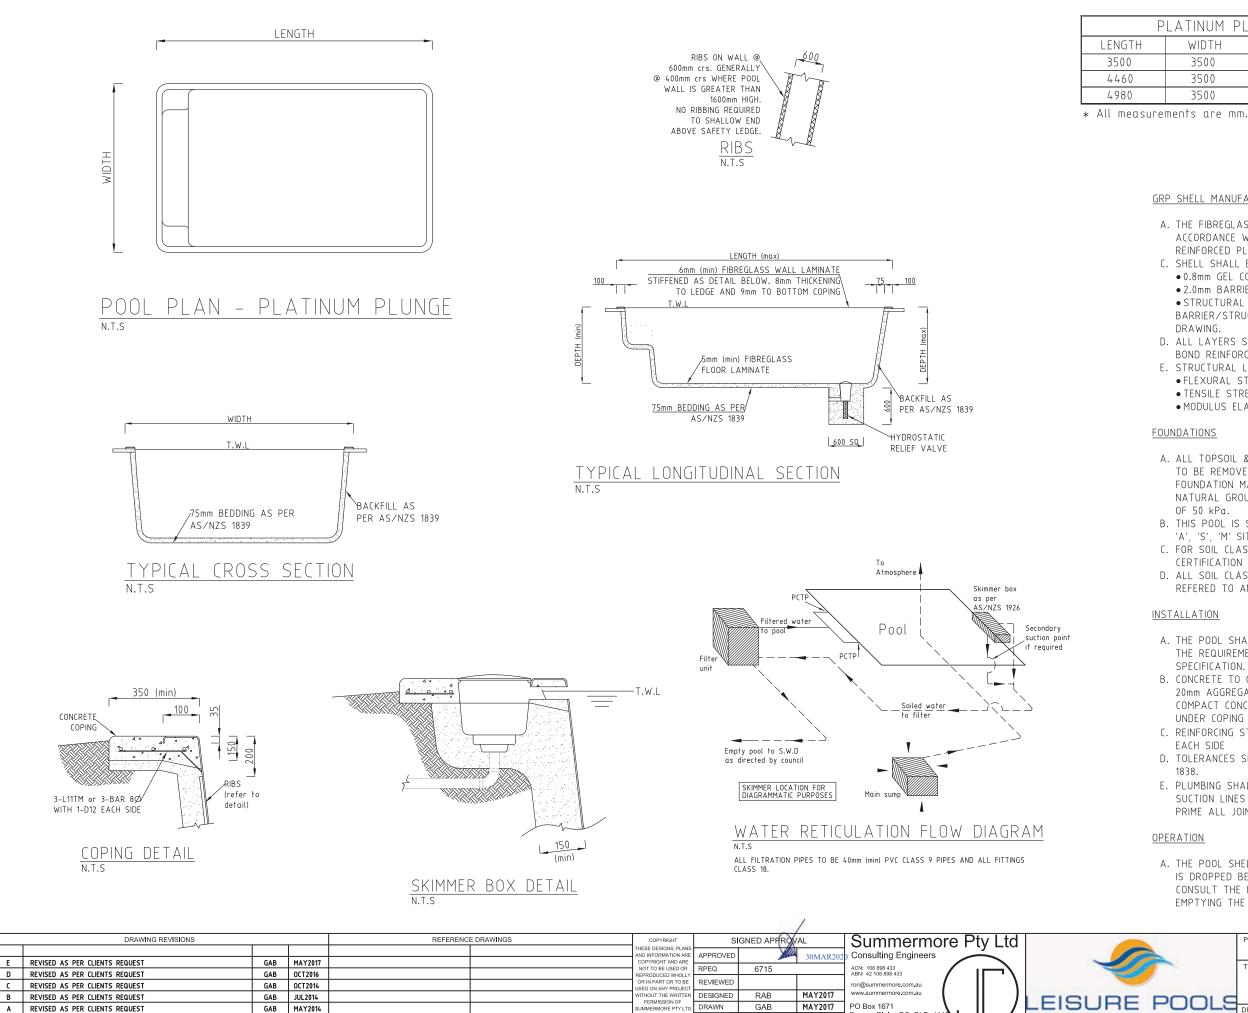

TITLE

DRAWING NAME

GAB APR2014

BY DATE

PRELIMINARY FOR CLIENT APPROVA

REV

DESCRIPTION





Browns Plains BC, QLD, 411 Phone: 07 3800 0973 Fax: 07 3800 1860

Fax:

LATINUM PLUNGE RANGE					
WIDTH	DEPTH (max)	DEPTH (min)			
3500	1600	1600			
3500	1600	1600			
3500	1600	1600			

GRP SHELL MANUFACTURE

- A. THE FIBREGLASS SHELL SHALL BE MANUFACTURED IN ACCORDANCE WITH AS/NZS 1838 (PRE-MOULDED FIBRE REINFORCED PLASTIC SWIMMING POOLS). C. SHELL SHALL BE SPRAY MOULDED WITH:
- 0.8mm GEL COAT (NPG).
- 2.0mm BARRIER COAT (VINYL ESTER).
- STRUCTURAL LAYER WHICH WILL GIVE TOTAL BARRIER/STRUCTURAL THICKNESS NOMINATED ON
- DRAWING
- D. ALL LAYERS SHALL BE ROLLED OUT TO COMPLETELY BOND REINFORCING & RESINS & EXPEL AIR.
- E. STRUCTURAL LAMINATE SHALL HAVE MINIMUM
- FLEXURAL STRENGTH OF 110 MPa. • TENSILE STRENGTH OF 60 MPa.
- MODULUS ELASTICITY OF 6200 MPa.

## FOUNDATIONS

- A. ALL TOPSOIL & ORGANIC MATTER UNDER POOL FLOOR IS TO BE REMOVED. THE DESIGN REQUIRES THAT THE FOUNDATION MATERIAL IS TO BE UNIFORM SOUND NATURAL GROUND WITH A MINIMUM BEARING CAPACITY OF 50 kPa.
- B. THIS POOL IS SUITABLE FOR SOIL CLASSIFICATIONS OF 'A', 'S', 'M' SITES.
- C. FOR SOIL CLASSIFICATIONS OF 'H' & 'E' SITES REFER TO
- CERTIFICATION LETTER FOR REQUIRED ADJUSTMENTS.
- D. ALL SOIL CLASSIFICATIONS OF 'P' SITES SHALL BE
- REFERED TO AN ENGINEER.

## INSTALLATION

- A. THE POOL SHALL BE INSTALLED IN ACCORDANCE WITH THE REQUIREMENTS OF AS/NZS 1839 & THIS SPECIFICATION.
- B. CONCRETE TO CONCOURSE SHALL BE 20 MPa (min), WITH 20mm AGGREGATE & 100±10 SLUMP - TYPE A CEMENT, COMPACT CONCRETE THOROUGHLY AROUND SKIMMER &
  - UNDER COPING FLANGE.
- C. REINFORCING STEEL: 3-L11TM or 3-BAR 80 WITH 1-D12 EACH SIDE
- D. TOLERANCES SHALL BE IN ACCORDANCE WITH AS/NZS 1838.
- E. PLUMBING SHALL BE 40Ø PRESSURE LINES AND 50Ø SUCTION LINES CLASS 9 PIPE AND CLASS 18 FITTINGS. PRIME ALL JOINTS BEFORE APPLYING SOLVENT.

## OPERATION

A. THE POOL SHELL MAY BE DAMAGED IF THE POOL WATER IS DROPPED BELOW NORMAL OPERATING LEVEL. CONSULT THE INSTALLATION CONTRACTOR PRIOR TO EMPTYING THE POOL.

	PROJECT Structural Details (Fibreglass Swimming	Pool)
×	TITLE	
	PLATINUM PLUNGE	
UULU	DRAWING NUMBER	REV
ND STYLE	14-7287-S07	E